



CH-C1

JOB NO: 1432.01

DATE: <u>4/24/2015</u>

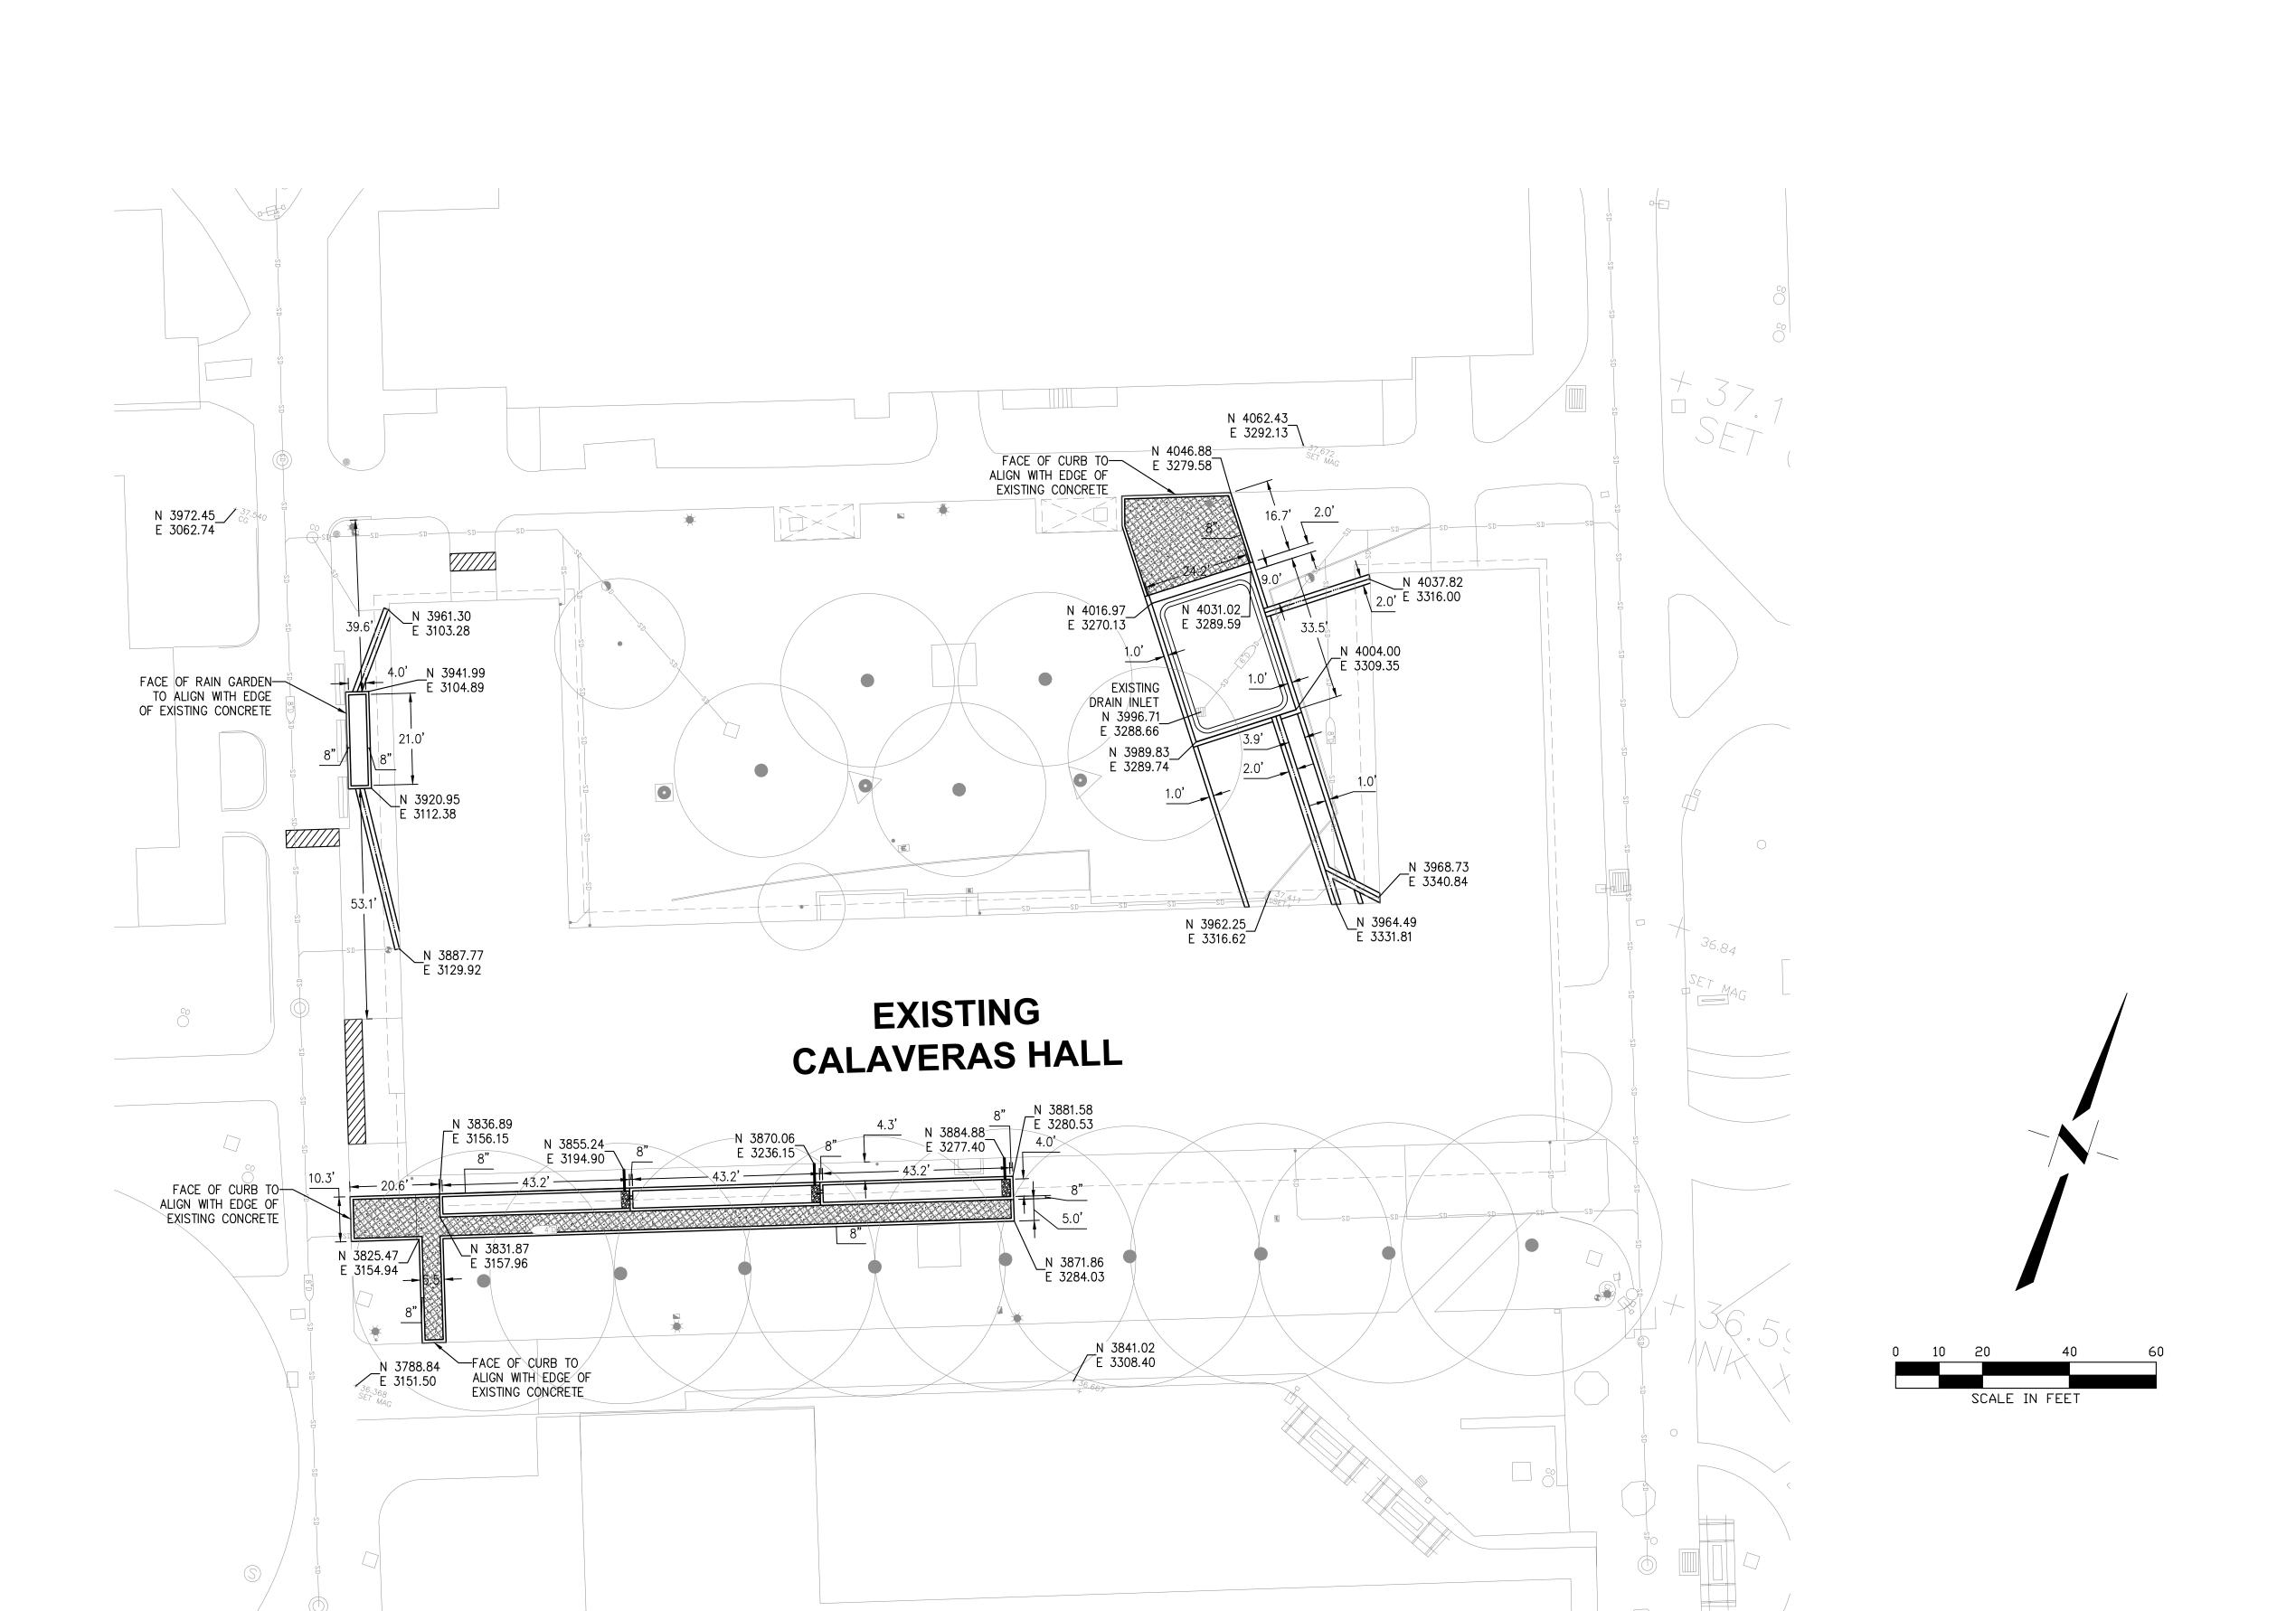



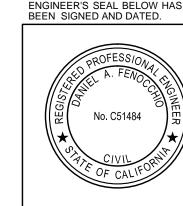


CH-C2

CONSTRUCTION DOCUMENTS
CSUS LID STORMWATER SYSTEM

CALAVERAS HALL
HORIZONTAL CONTROL

DATE: 4/24/2015 JOB NO: 1432.01

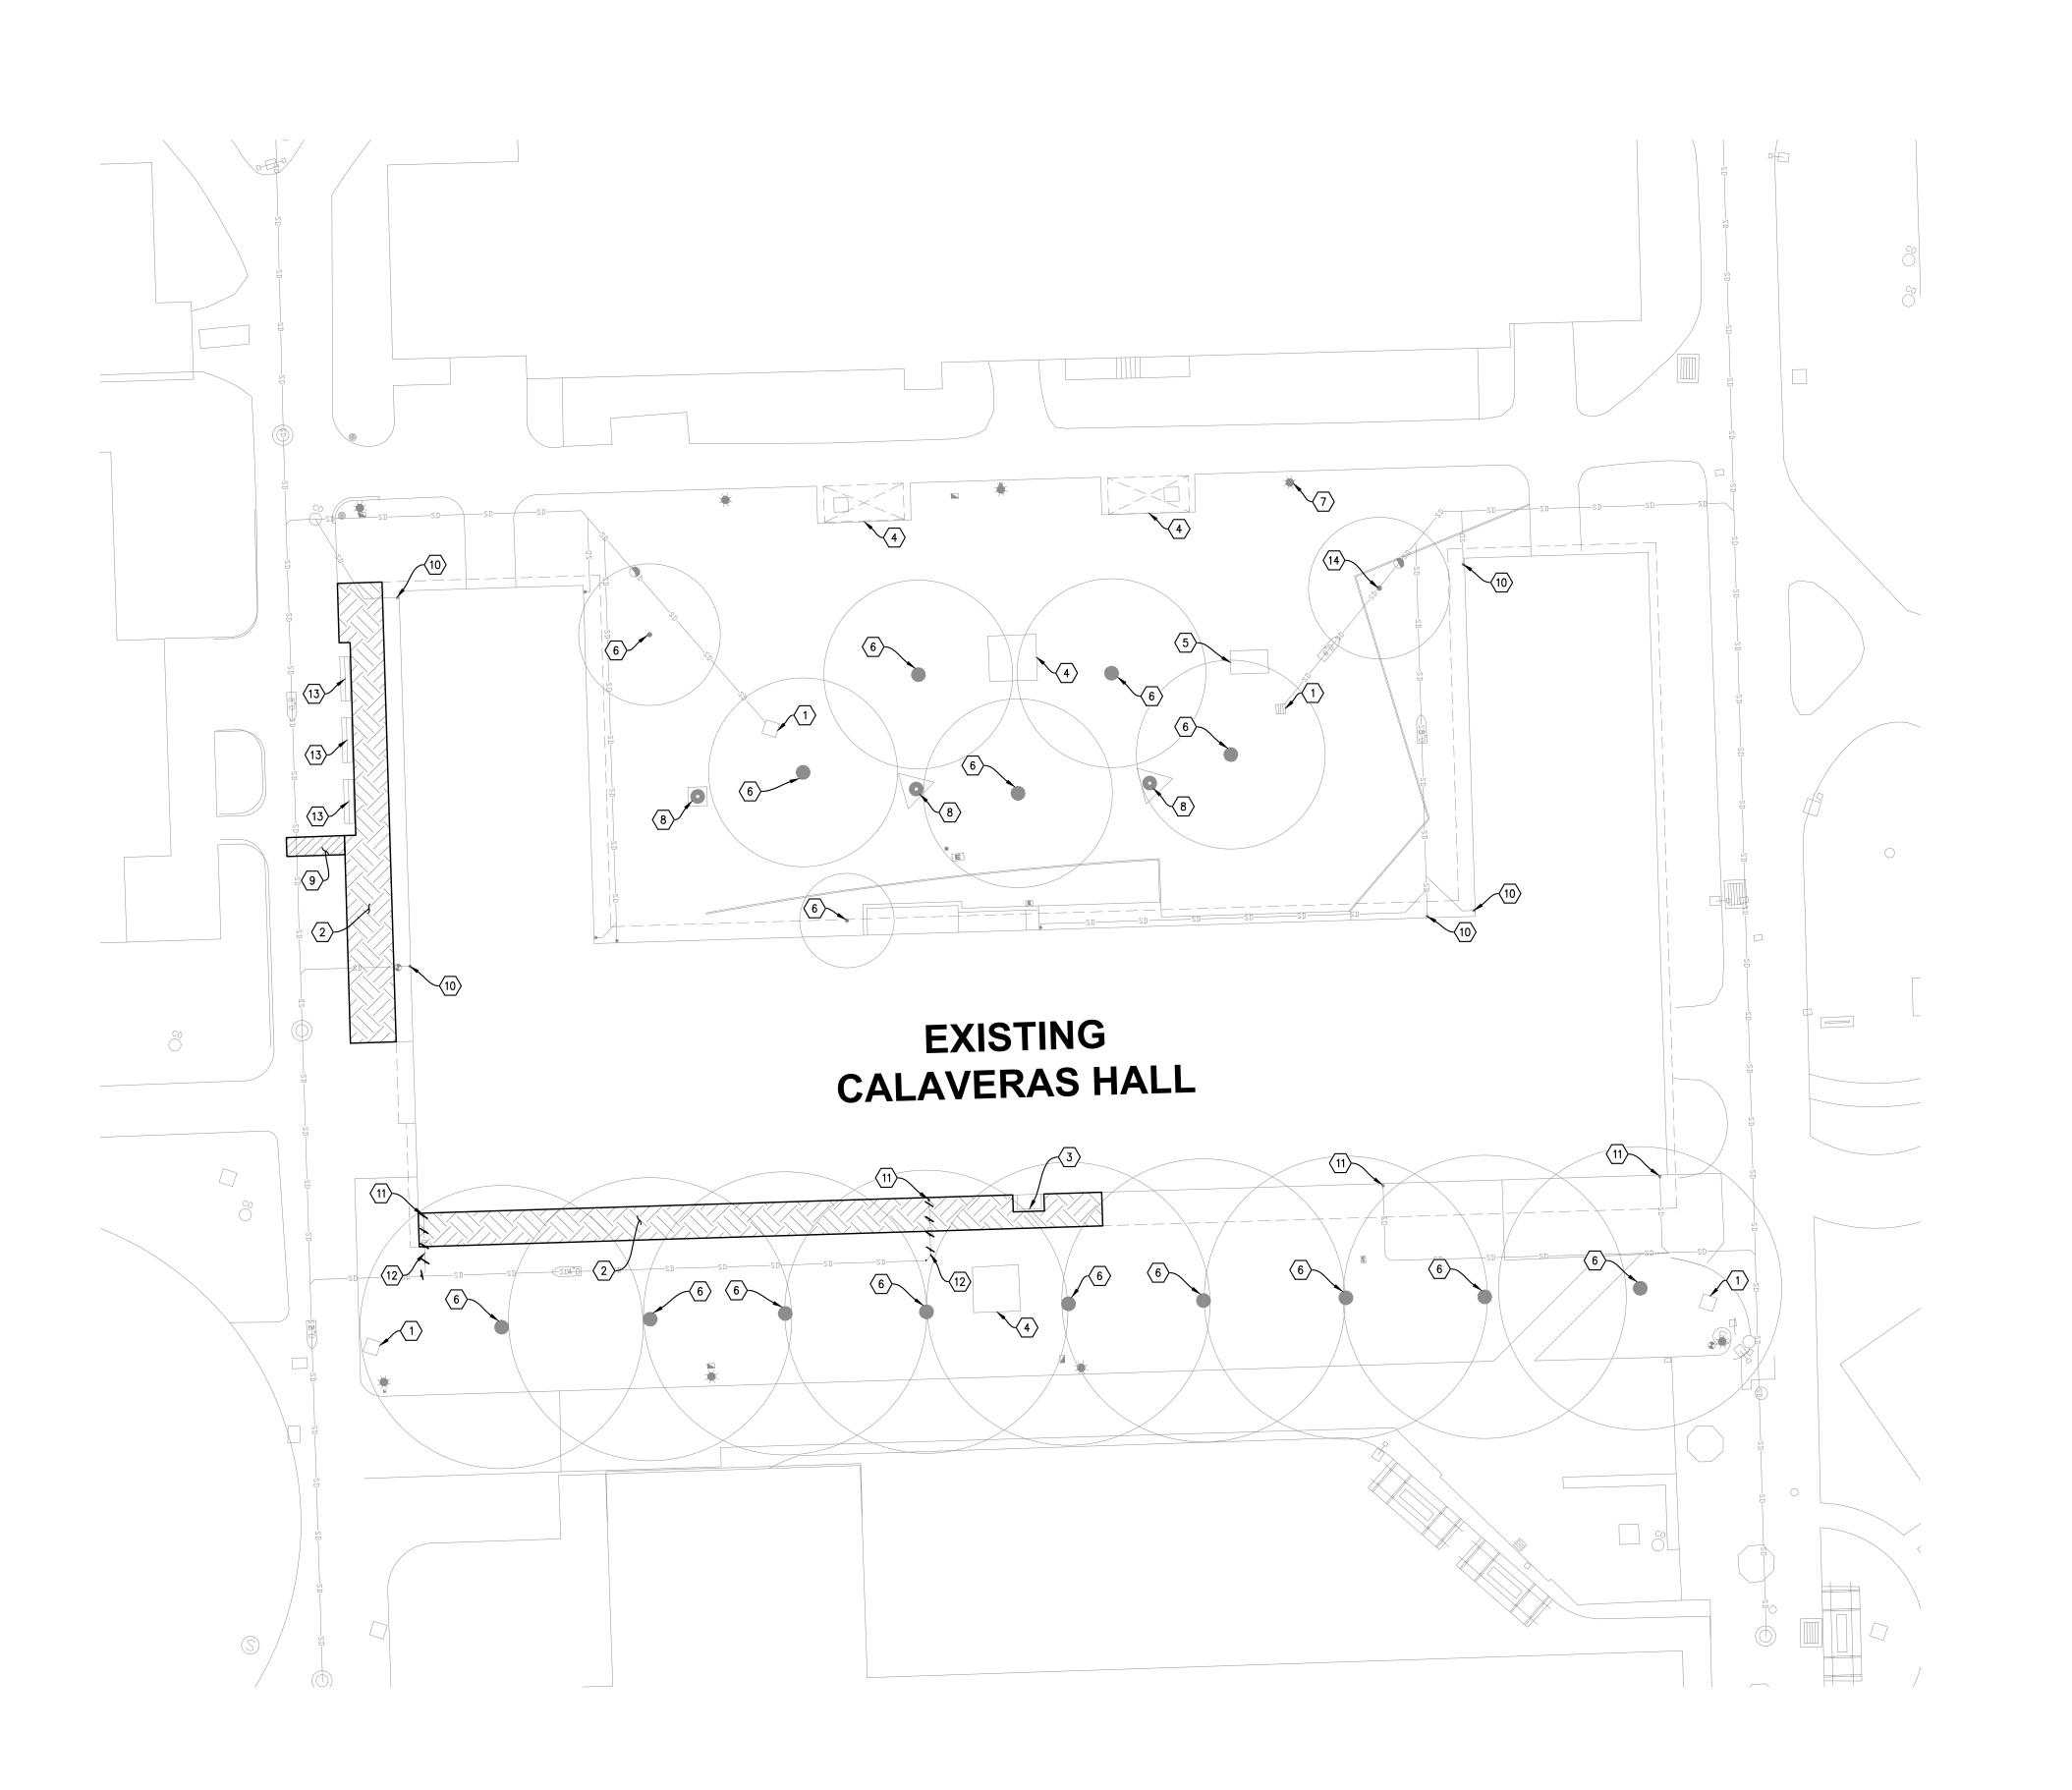


KEYNOTES:

- 1) EXISTING DRAIN INLET TO REMAIN. CONTRACTOR SHALL PROTECT DURING CONSTRUCTION.
- REMOVE EXISTING VEGETATION TO MINIMUM LIMITS SHOWN.
- 3 PROTECT AND COVER EXISTING BASEMENT ACCESS.
- 4 PROTECT EXISTING CONCRETE PAD AND PICNIC/SEATING AREA.
- 5 REMOVE EXISTING CONCRETE PAD AND PICNIC TABLE/SEATING AREA.
- PROTECT EXISTING TREE TO REMAIN. SEE SHEET T-3 FOR TREE PROTECTION NOTES.
- 7 PROTECT EXISTING LIGHT POLE TO REMAIN.
- (8) PROTECT EXISTING SATELLITE DISH TO REMAIN.
- 9 SAWCUT AND REMOVE EXISTING AC PAVEMENT TO MINIMUM LIMITS SHOWN.
- DISCONNECT DOWNSPOUT PIPE FROM UNDERGROUND STORM DRAIN. CAP STORM DRAIN PIPE AT GRADE.
- PLUG DOWNSPOUT CONNECTION AT GUTTER AND REMOVE EXISTING DOWNSPOUT PIPE.
- (12) REMOVE EXISTING 3" STORM DRAIN PIPE.
- (13) EXISTING BENCH TO REMAIN.
- (14) REMOVE EXISTING TREE.

NOTES:

- 1. SEE SHEET CH-C1 FOR IRRIGATION TRENCH IMPROVEMENTS.
- 2. INTENT OF DEMOLITION PLAN IS TO PROVIDE GENERAL SITE DEMOLITION REQUIREMENTS TO CONTRACTOR. PLAN IS NOT INTENDED TO PROVIDE DETAILED INFORMATION ON SITE REMOVAL, PROTECTION AND PHASING. CONTRACTOR SHALL BE RESPONSIBLE FOR PERFORMING SITE VISITS TO DEVELOP A DETAILED DEMOLITION PLAN IN ACCORDANCE WITH THE PROPOSED SITE IMPROVEMENTS.
- 3. SITE DEMOLITION INCLUDES:
 - REMOVE EXISTING ASPHALT AND CONCRETE PAVEMENT.
 - REMOVE EXISTING STORM DRAIN PIPE AND DOWNSPOUT.
 - REMOVE EXISTING VEGETATION.
 - REMOVE EXISTING TREE INCLUDING ROOTS.
- 4. CONTRACTOR SHALL DISPOSE OF ALL MATERIALS PROPERLY OFFSITE.
- 5. LIMITS OF REMOVAL SHOWN ON THESE PLANS ARE APPROXIMATE. CONTRACTOR SHALL MODIFY LIMITS OF DEMOLITION AS NECESSARY TO PROVIDE FOR NEW CONSTRUCTION, BASED ON CONTRACTOR'S METHOD OF CONSTRUCTION.
- 6. CONTRACTOR SHALL PROVIDE TRAFFIC CONTROL FLAGGING FOR VEHICULAR INGRESS/EGRESS.
- 7. PROJECT VEHICULAR AND PEDESTRIAN ACCESS PLAN SHALL BE PREPARED BY CONTRACTOR.
- 8. THE TYPES, LOCATIONS, SIZES AND/OR DEPTHS OF EXISTING UTILITIES SHOWN ON THESE PLANS WERE OBTAINED FROM SOURCES OF VARYING RELIABILITY. THE CONTRACTOR IS CAUTIONED THAT ONLY ACTUAL EXCAVATION WILL REVEAL THE TYPES, EXTENT, SIZE, LOCATION AND DEPTH OF SUCH UNDERGROUND FACILITIES. HOWEVER, THE ENGINEER CAN ASSUME NO RESPONSIBILITY FOR THE COMPLETENESS OR ACCURACY OF ITS DELINEATION OF SUCH UNDERGROUND FACILITIES NOR FOR THE EXISTENCE OF OTHER BURIED OBJECTS WHICH ARE NOT SHOWN ON THESE PLANS. IF NO ELEVATION IS SHOWN ON THE PLANS THE CONTRACTOR SHALL ASSUME THE ELEVATION IS UNKNOWN.
- 9. SEE SHEET T-3 FOR TREE PROTECTION NOTES.

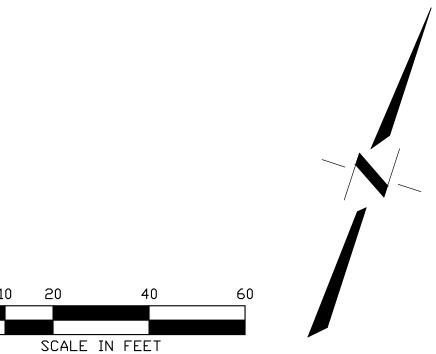

DATE SIGNED: _____
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CH-C3


DATE: <u>4/24/2015</u> JOB NO: 1432.01

CONSTRUCTION DOCUMENTS
CSUS LID STORMWATER SYSTEM

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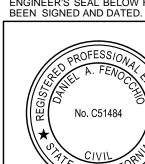
EDGE OF ROOF OVERHANG

CH-RG-3

1"=10'

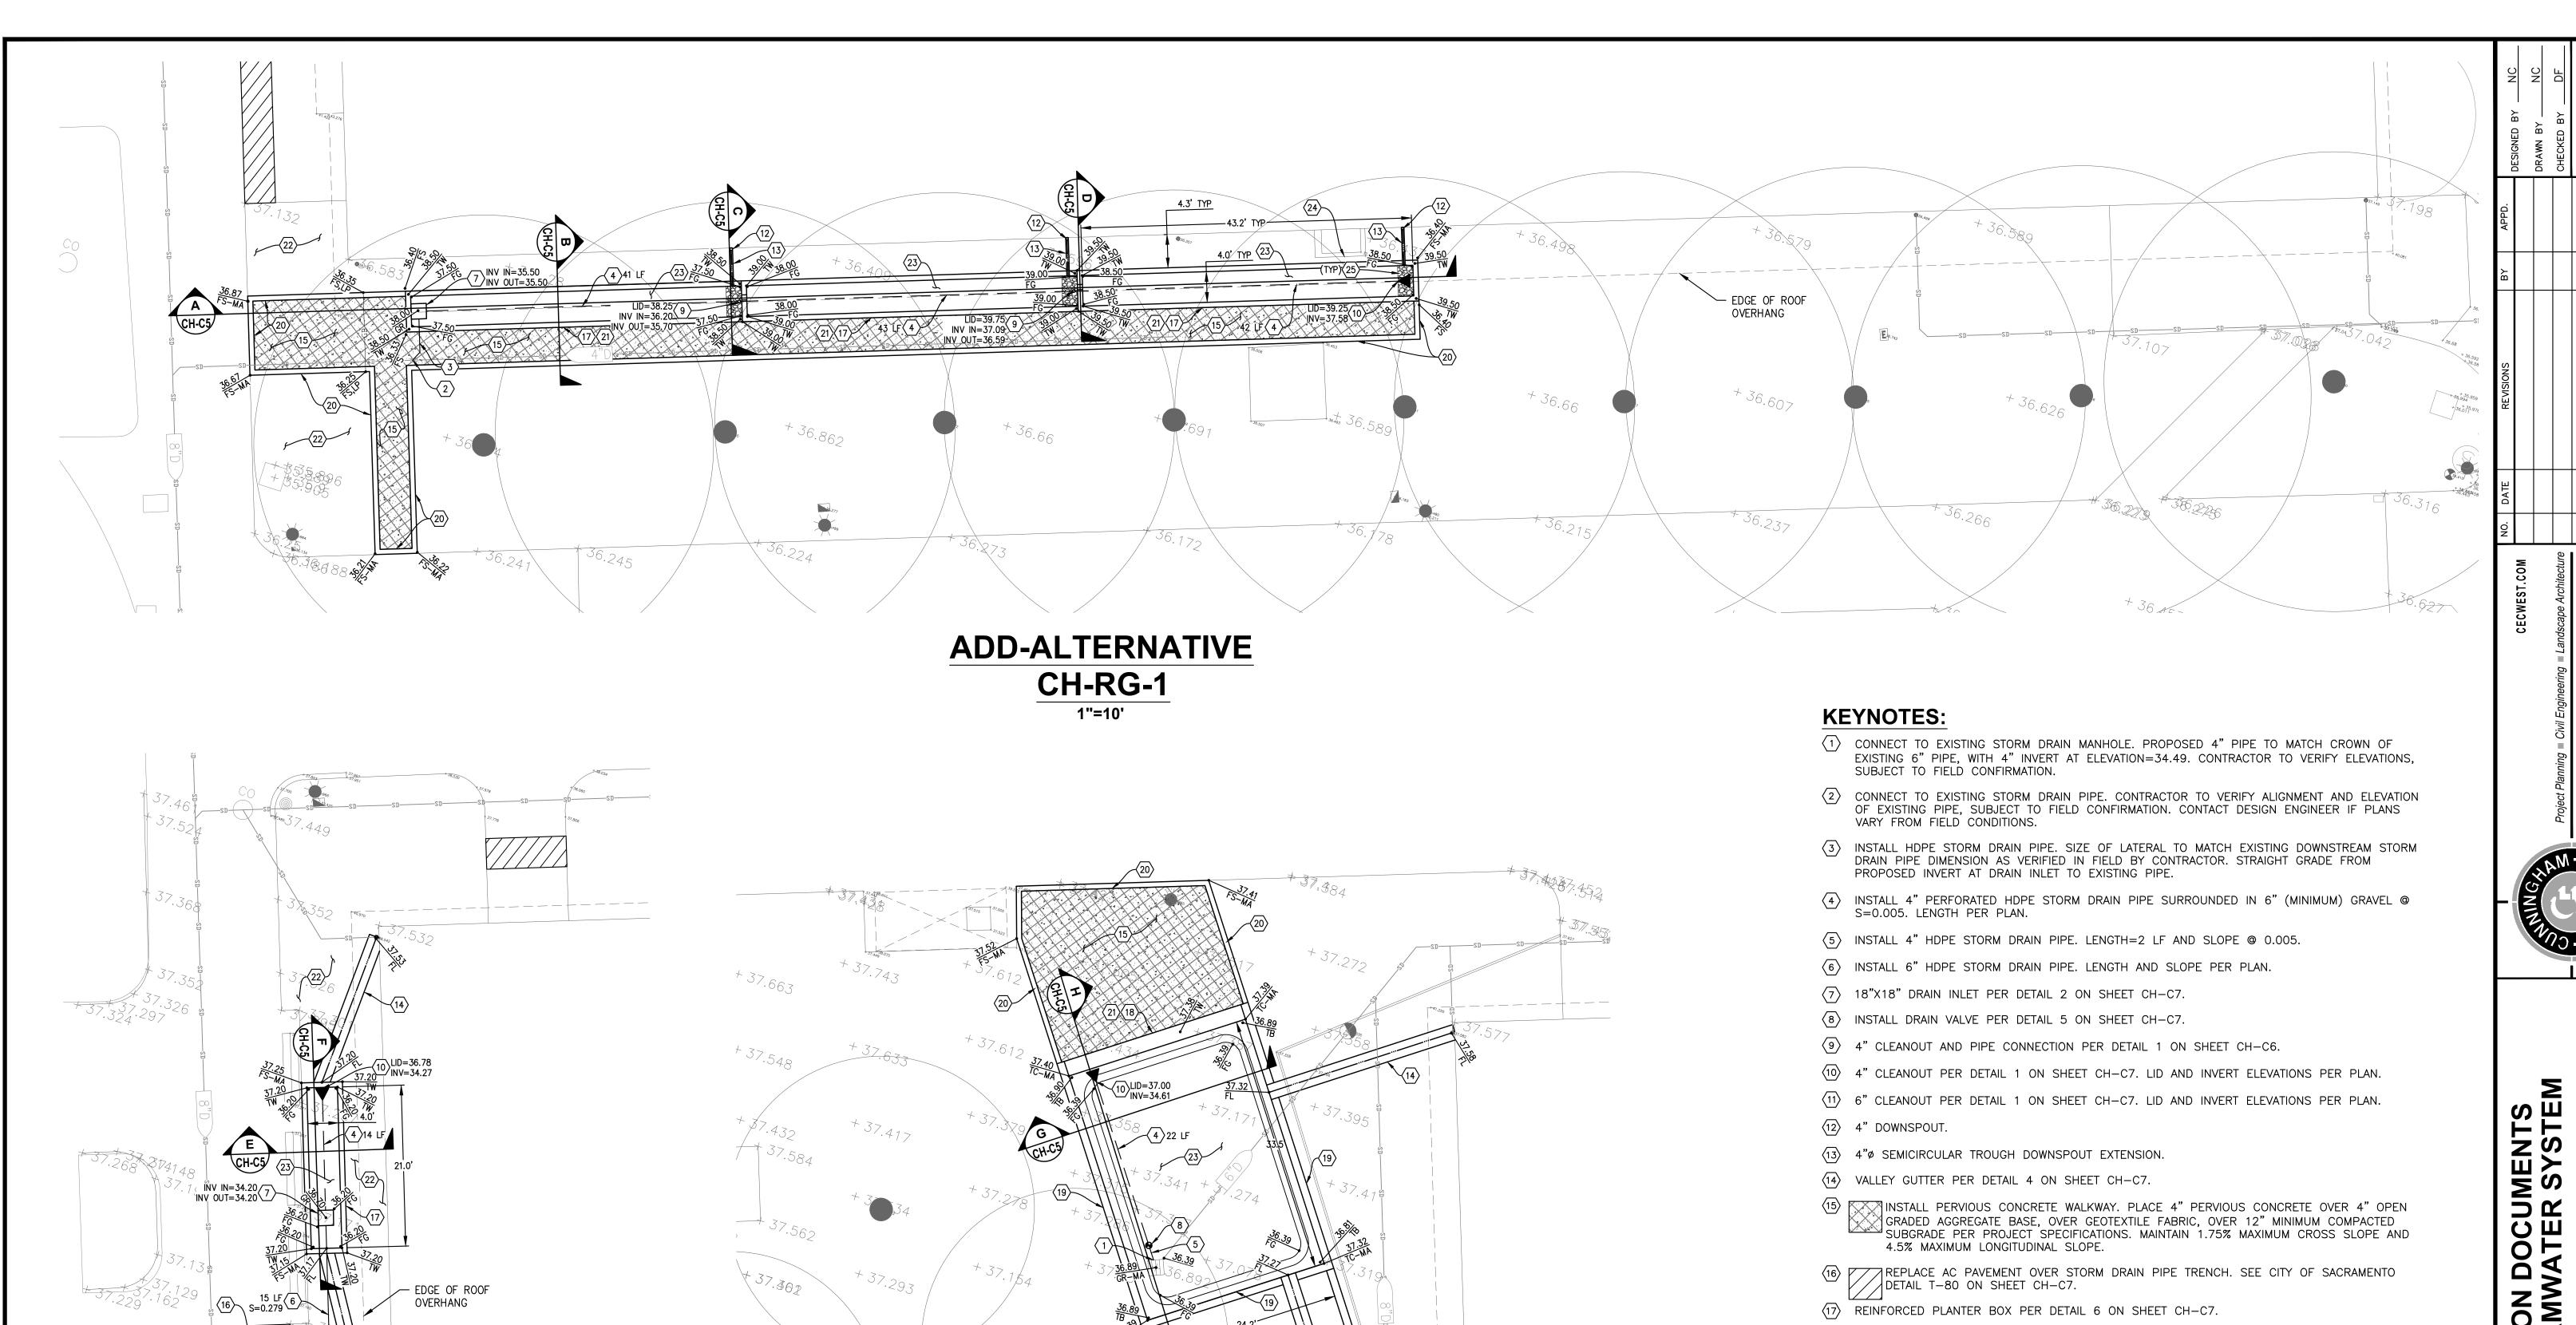CH-RG-2

1"=10'



NOTES:

SCALE IN FEET

1. SEE CH-C1 FOR IRRIGATION TRENCH IMPROVEMENTS.

(25) 4" COBBLE. SEE SECTION A ON SHEET CH-C5 FOR DETAILS.

EXISTING BASEMENT VENT. CONTRACTOR TO VERIFY LOCATION. CONTACT DESIGN ENGINEER IF PLANS VARY FROM FIELD CONDITIONS.

(18) CONCRETE WALL. SEE LANDSCAPE PLANS FOR DETAILS.

(19) 12" MOW STRIP. SEE LANDSCAPE PLANS FOR DETAILS.

22 NATIVE PLANTS. SEE LANDSCAPE PLANS FOR DETAILS.

20 FLUSH CURB PER DETAIL 3 ON SHEET CH-C7.

(21) CONCRETE WALL FINISH PER LANDSCAPE PLANS.




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CH-C4

DATE: <u>4/24/2015</u>


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CH-C5

DATE: <u>4/24</u>/2015 JOB NO: 1432.01

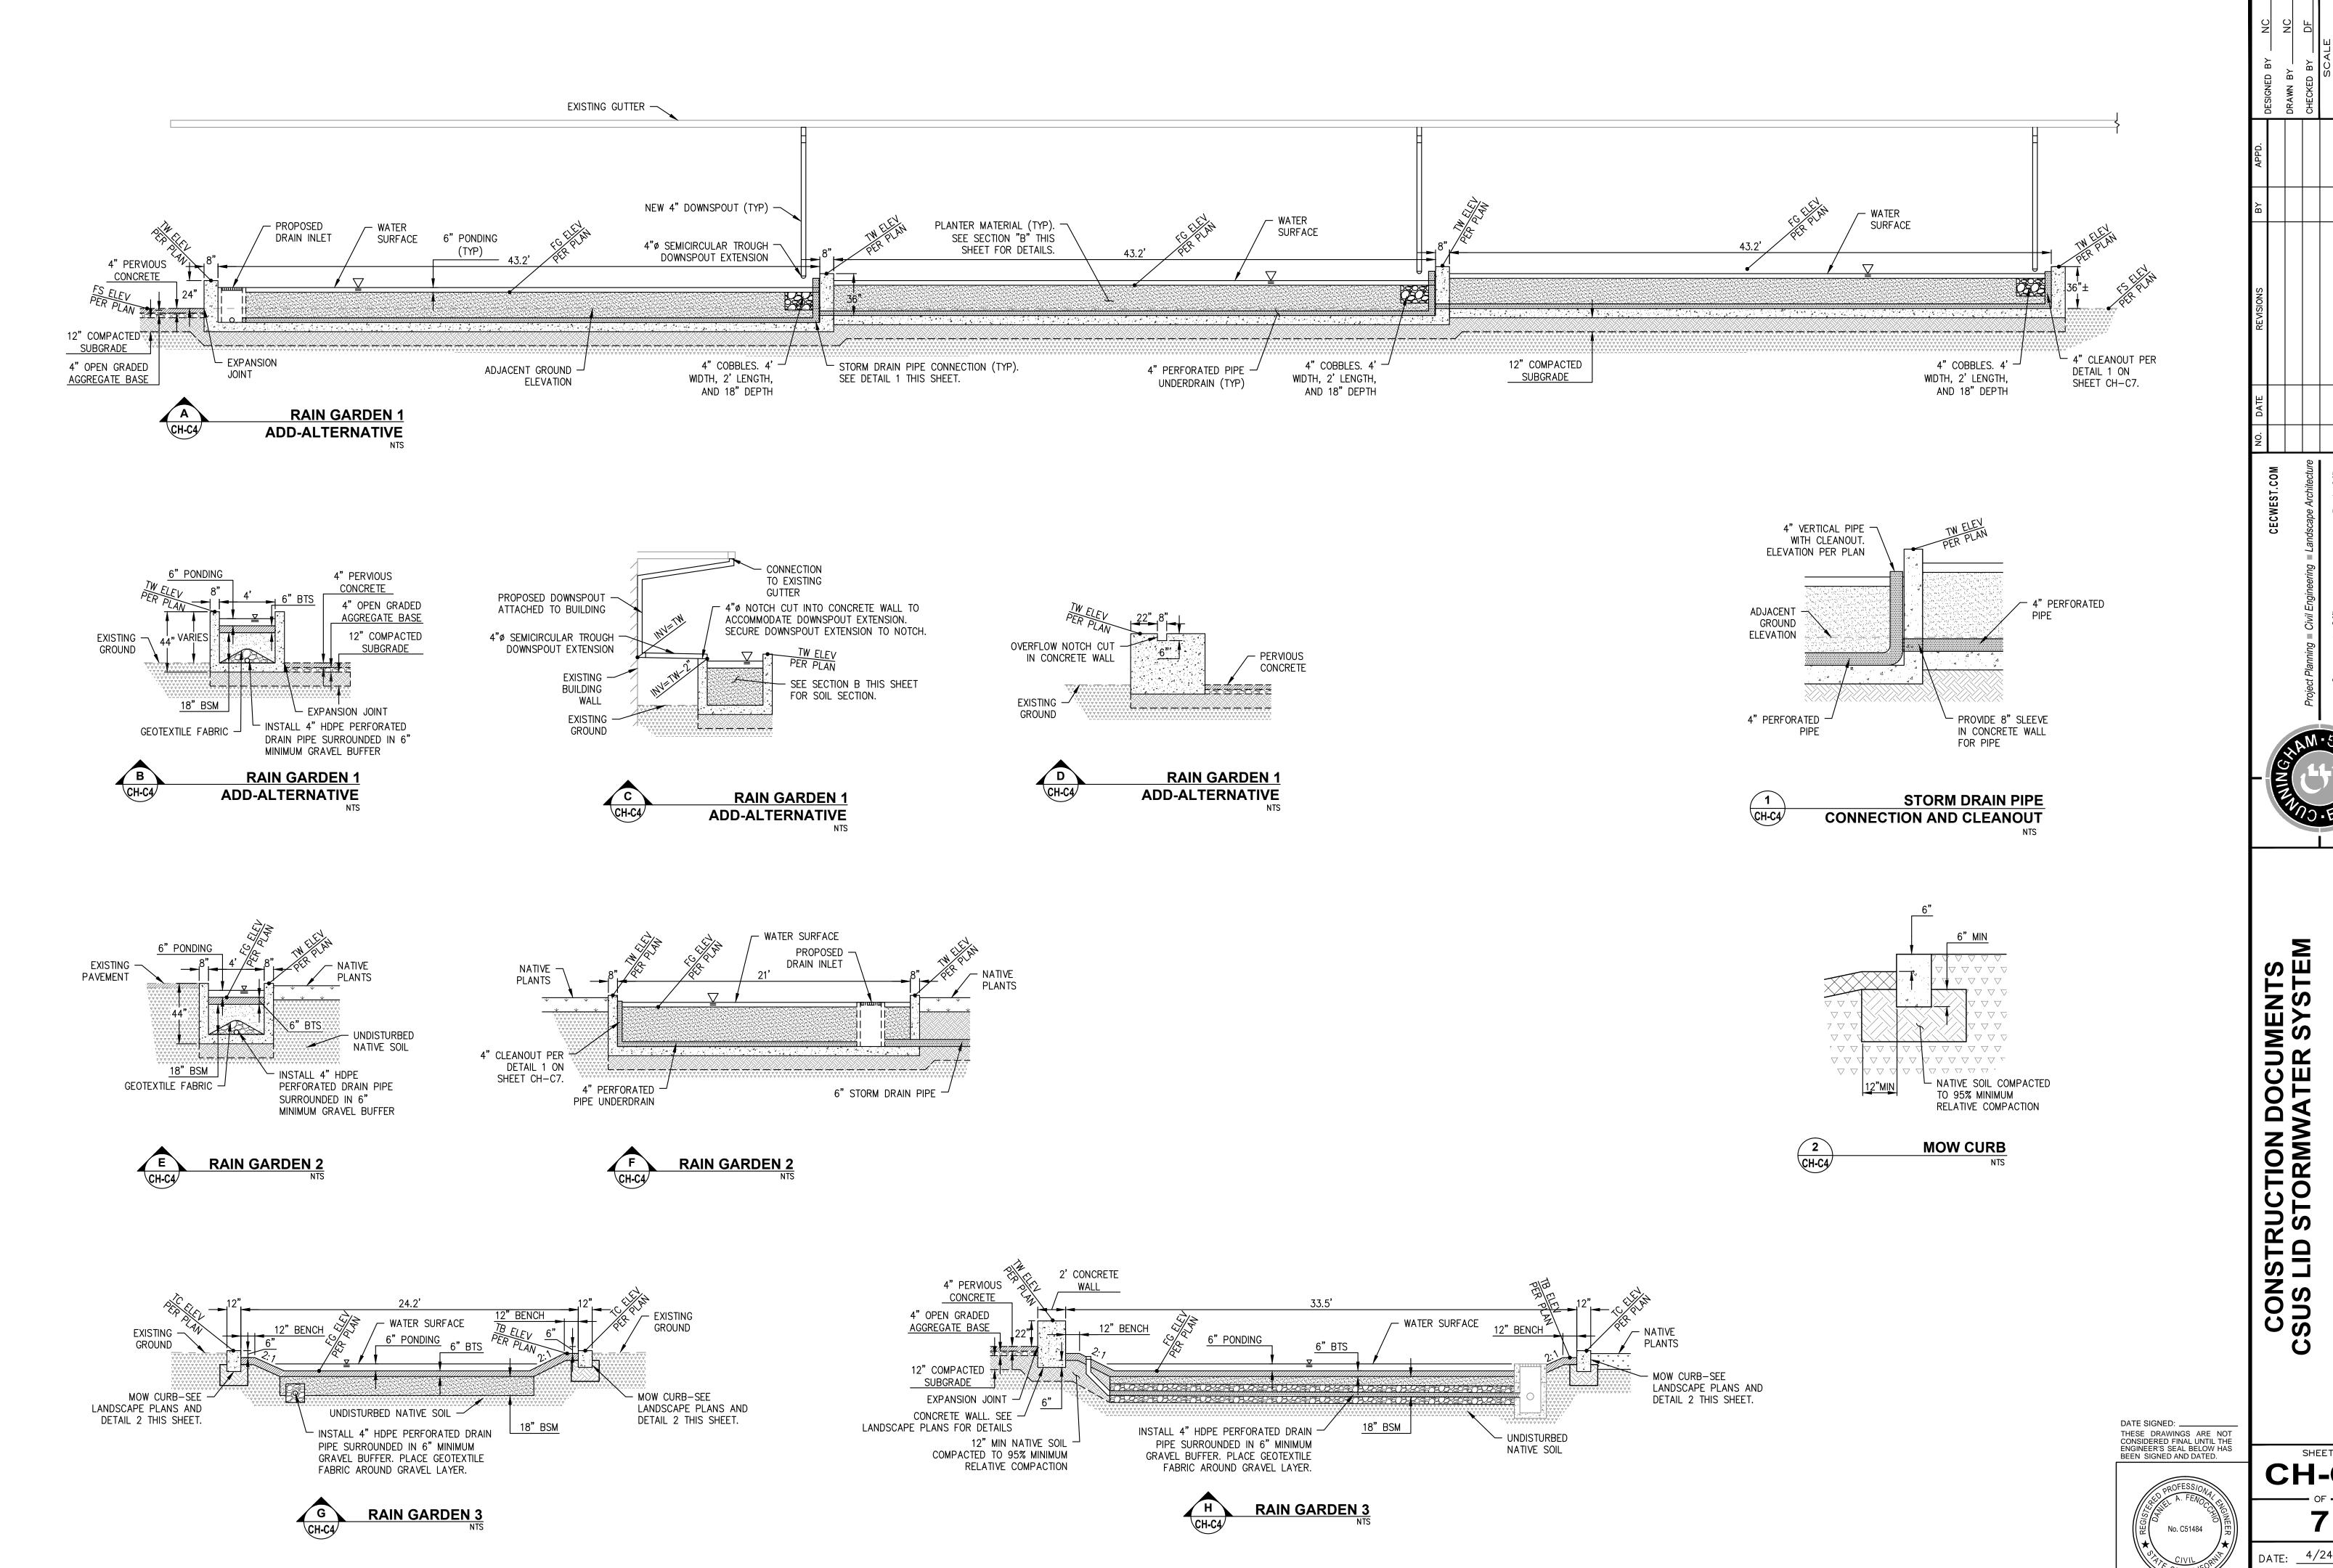



KEYNOTES


- $\langle 1 \rangle$ INSTALL FIBER ROLL PER CITY OF SACRAMENTO STANDARD DWG. NO. Q-40.
- (2) INSTALL STORM DRAIN INLET SEDIMENT CONTROL AND FILTER BAG PER CITY OF SACRAMENTO STANDARD DWG. NOs. Q-20 & Q-30.

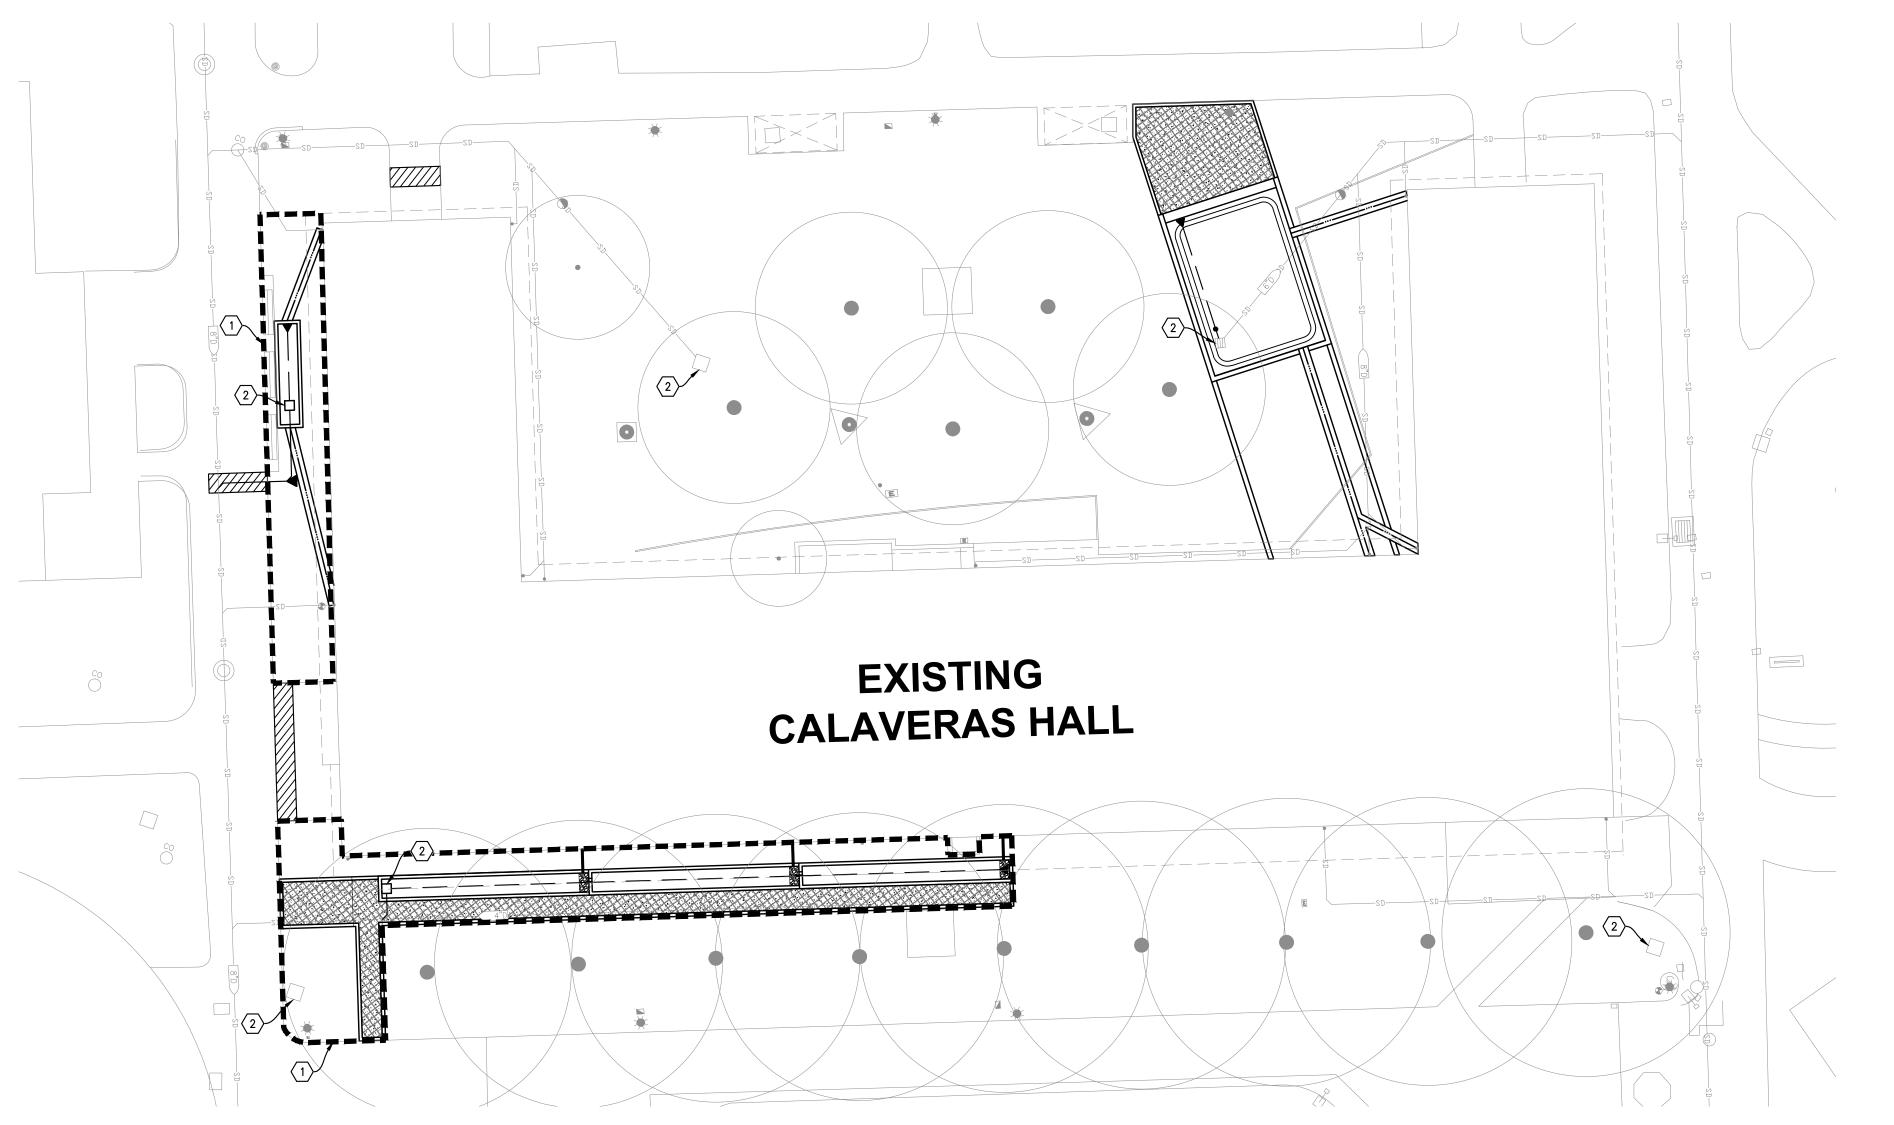
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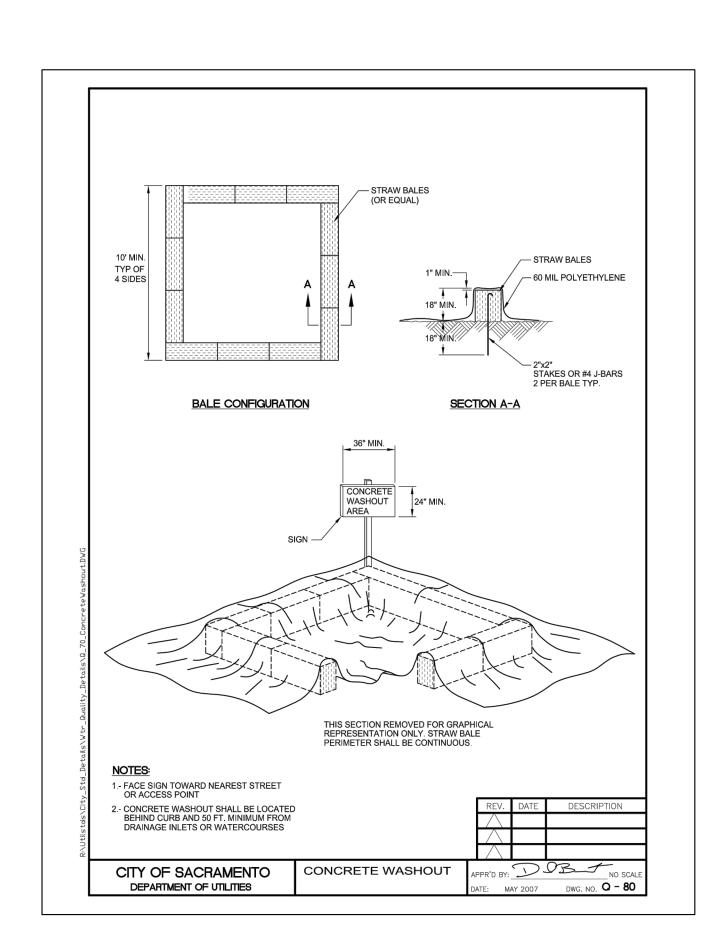
- 1. REFER TO SHEET T-3 FOR EROSION CONTROL NOTES.
- 2. CONTRACTOR SHALL PROVIDE CONCRETE WASHOUT AREA PER CITY OF SACRAMENTO STANDARD DWG. NO. Q—80. CONTRACTOR SHALL COORDINATE LOCATION WITH CSUS REPRESENTATIVE PRIOR TO CONSTRUCTION.
- 3. CONTRACTOR SHALL COORDINATE WITH CSUS REPRESENTATIVE FOR MATERIAL STORAGE LOCATION PRIOR TO CONSTRUCTION.




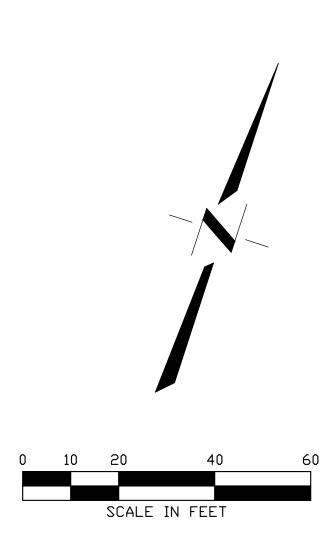

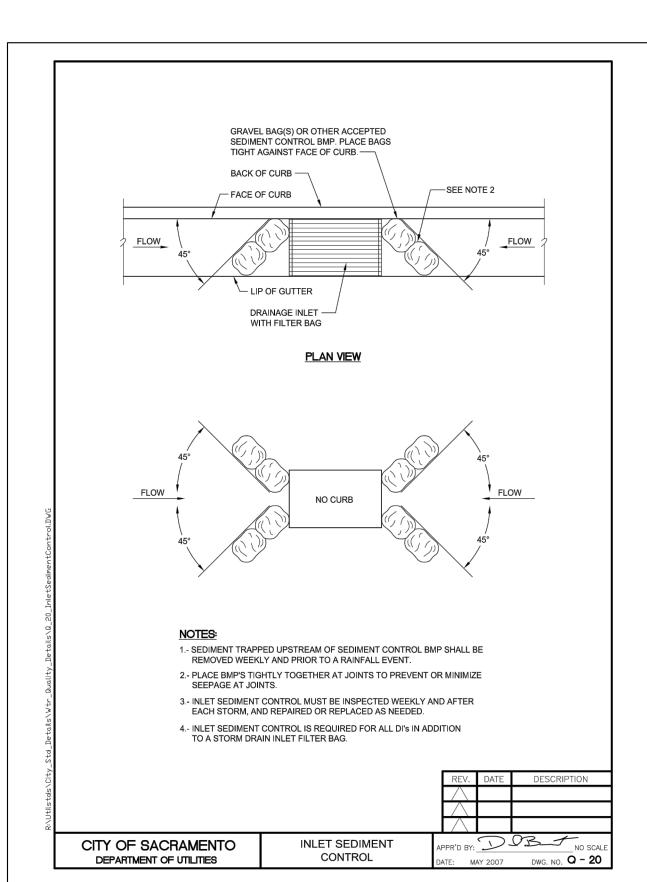

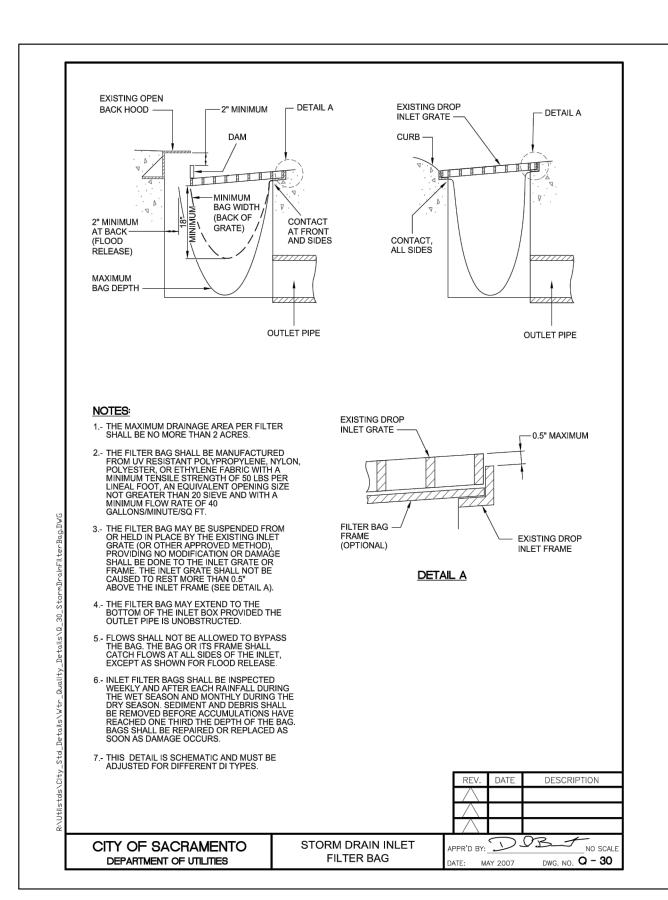

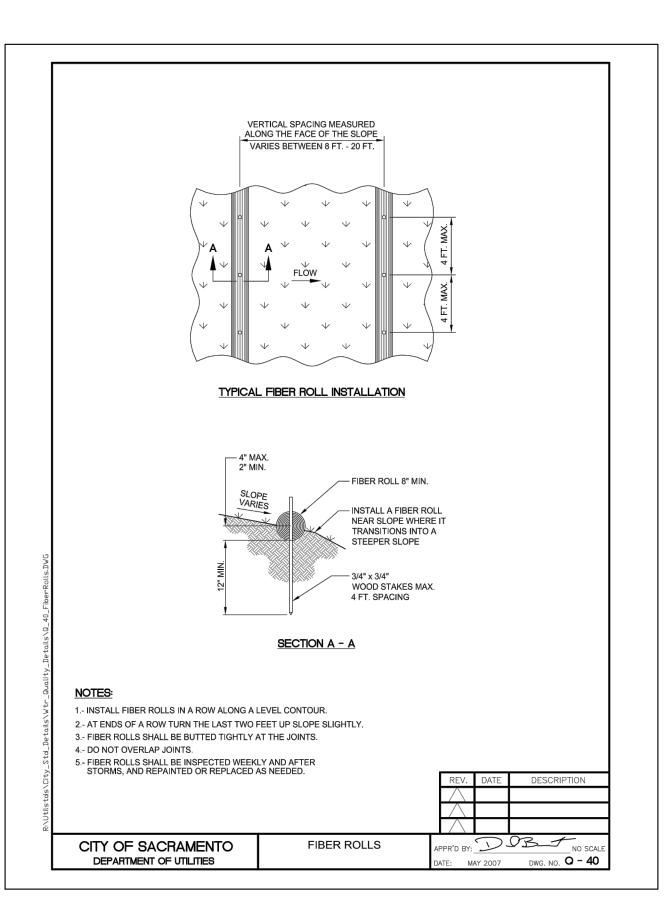

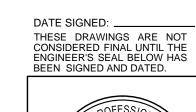



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CH-C6

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CH-C6

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DATE: 4/24/2015

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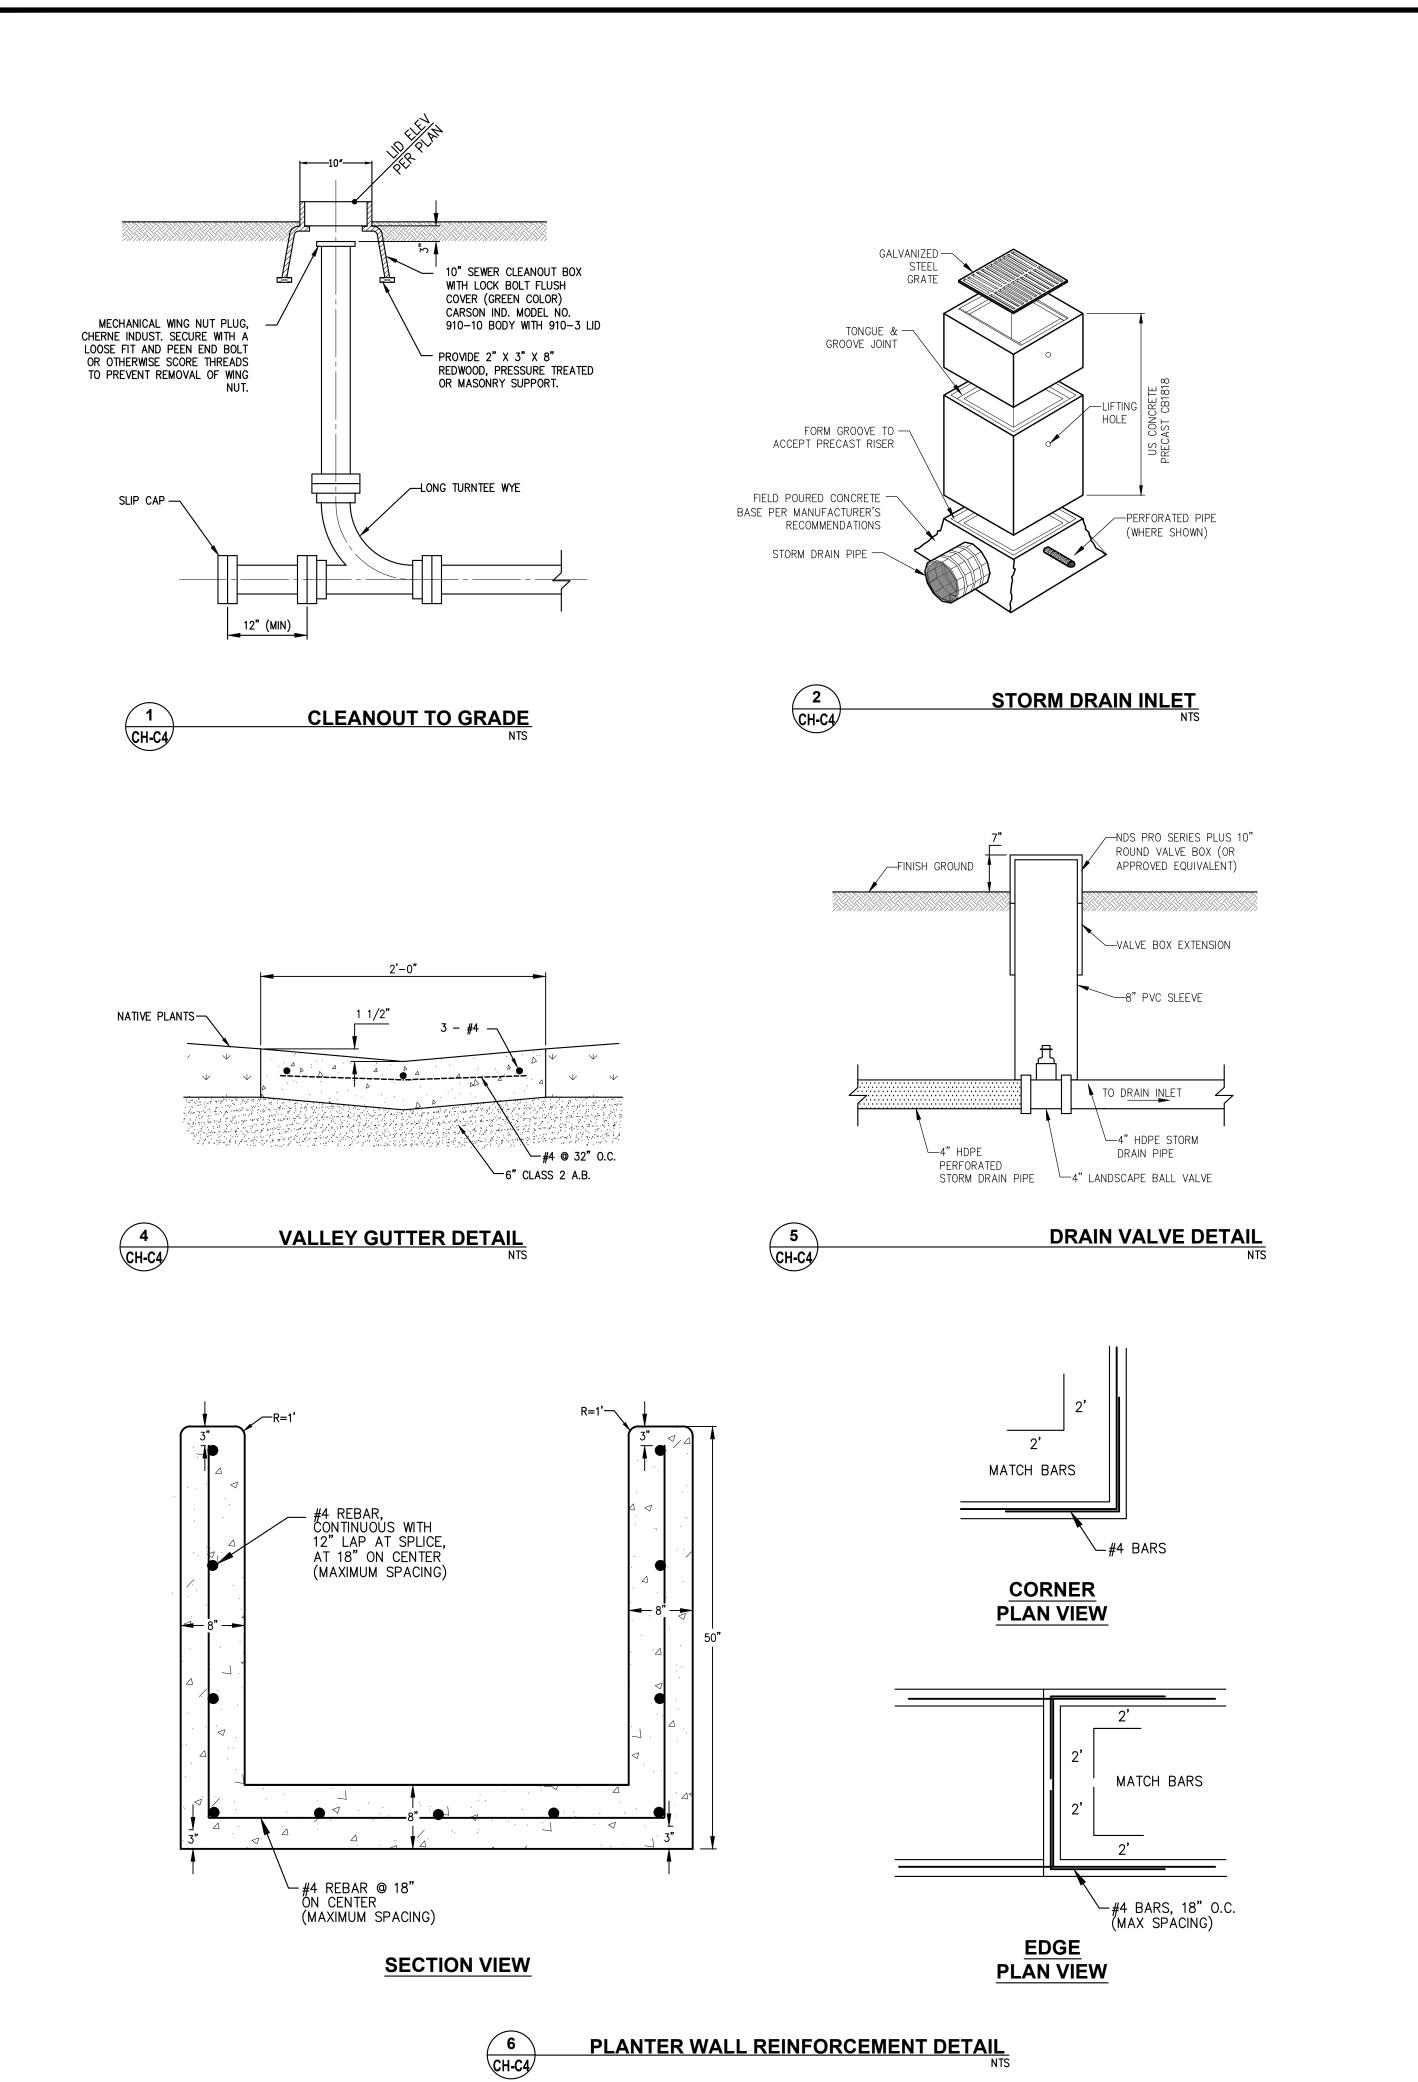
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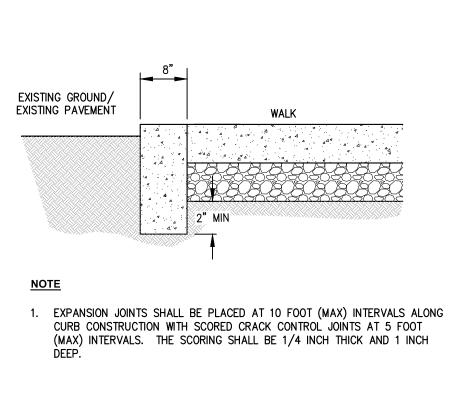
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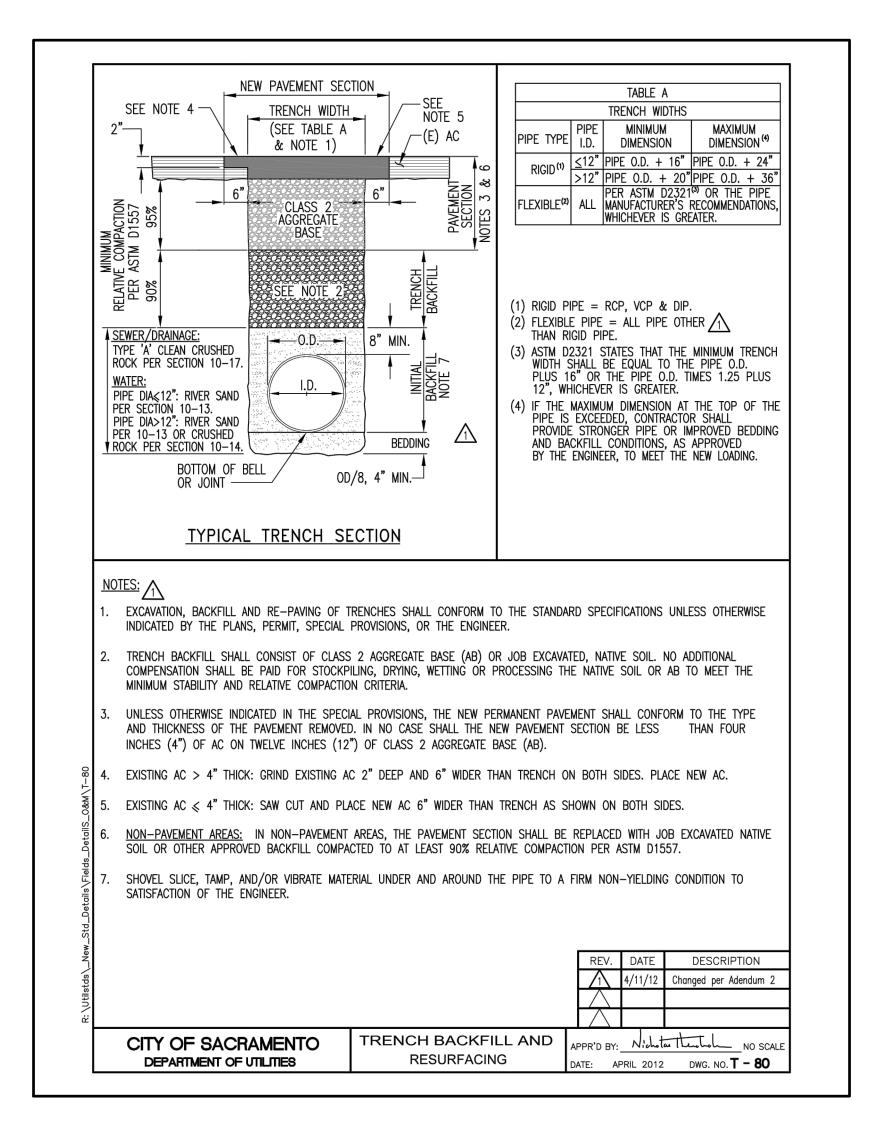
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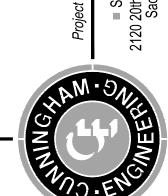
S LID STORMWATER SY CALAVERAS HALL EROSION CONTROL PLA





FLUSH CURB CH-C4





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CONSTRUCTION DOCUMENTS SUS LID STORMWATER SYSTEM DETAIL VERA

CH-C7

JOB NO: 1432.01



DATE SIGNED: ______
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